

June 19, 2009

**ADDENDUM NO. 1
FOR THE
PENITENCIA CREEK TRAIL REACH 6 INTERIM IMPROVEMENTS**

Notice is hereby given that the following revisions, additions and/or deletions are hereby made of, and incorporated into plans and specifications for the **PENITENCIA CREEK TRAIL REACH 6 INTERIM IMPROVEMENTS PROJECT**.

BID DOCUMENTS

PROPOSAL TO CITY OF SAN JOSE

SCHEDULE OF QUANTITIES:

DELETE: The Schedule of Quantities

REPLACE: with the Attached Schedule of Quantities

CONTRACT

SCHEDULE OF QUANTITIES:

DELETE: The Schedule of Quantities

REPLACE: with the Attached Schedule of Quantities

SPECIFICATIONS:

GENERAL

ADD: Attached Appendix 1

SECTION 10-9 ASPHALT CONCRETE – TRAIL IMPROVEMENTS

DELETE paragraph 3: Asphalt Surface Course for trail improvements: All asphalt surface course shall be Type "A", 3/4 inch maximum size aggregate, coarse class asphalt concrete as specified in Section 39, "Asphalt Concrete", of the City Standard Specifications.

REPLACE with the following: Asphalt Surface Course for trail improvements: All asphalt surface course shall be Type "A", 1/2 inch maximum size aggregate, medium class asphalt concrete as specified in Section 39, "Asphalt Concrete", of the City Standard Specifications.

Penitencia Creek Trail Reach 6 Interim Improvements

Addendum 1

June 19, 2009

Page 2 of 2

SECTION 10-13 CARPENTRY

DELETE section 10-13.3.2: Header board shall be constructed and installed in accordance with the details as shown on the plans.

ADD: The attached Appendix 1 to the end of your specifications.

PLANS:

SHEET 7 SITE LAYOUT PLAN

ADD: Attached Addendum 1 - Drawing 1 of 5 dated 6/17/09 from Callander Associates

SHEET 8 SITE LAYOUT PLAN

ADD: Attached Addendum 1 - Drawing 2 of 5 dated 6/17/09 from Callander Associates

SHEET 9 DETAILS

DELETE: details 3, 6 and 8.

REPLACE with: Attached Addendum 1 - Drawings 3 thru 5 dated 6/17/09 from Callander Associates


SHEET 11 DETAILS

ADD: Coastal Conservancy Logo to temporary construction sign per attached guidelines.
Actual logo will be provided at pre-construction meeting.

INSTRUCTIONS TO BIDDER:

The bidder must sign this addendum in the space provided below and return one signed copy with the bid. Failure to return the signed copy with the bid documents shall not relieve the bidder of the obligation to include this addendum with the bid proposal.

APPROVED BY:


for Katy Allen
Director
Public Works Department

Bidder's Name

Date

Signature & Title of Bidder

SCHEDULE OF QUANTITIES FOR

APPENDIX 1

PERMIT

**STATE OF CALIFORNIA
DEPARTMENT OF FISH AND GAME**

DEPARTMENT OF FISH AND GAME

BAY DELTA REGION

(707)944-5520

Mailing Address


POST OFFICE BOX 47

YOUNTVILLE, CALIFORNIA 94599

Street Address

7329 SILVERADO TRAIL

NAPA, CALIFORNIA 94558

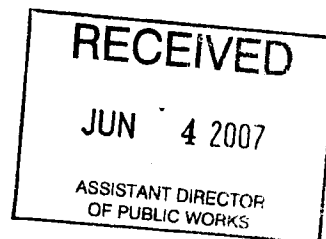

May 30, 2007

David Sykes, Assistant Director
City of San Jose
Department of Public Works
200 E. Santa Clara Street, 5th Floor Tower
San Jose, CA 95113

Dear Mr. Sykes:

Notification of Lake or Streambed Alteration
Notification No. 1600-2007-0108-3
Penitencia Creek, Santa Clara County

As the Department explained in its letter to you dated April 6, 2007, the Department had until May 18, 2007, to submit a draft Lake or Streambed Alteration Agreement to you or inform you that an agreement is not required. Due to staffing constraints, the Department was unable to meet that date. As a result, by law, you may now complete the project described in your notification without an agreement. In doing so, however, the project must be the same one and conducted in the same manner as described in the notification. That includes completing the project within the proposed term and seasonal work period and implementing all mitigation and avoidance measures to protect fish and wildlife resources specified in the notification. (Fish and Game Code section 1602(a)(4)(D).) The work period that you submitted in your notification is January 1, 2007 until December 31, 2009. This work period cannot be modified or extended by the Department.

If your project differs from the one described in the notification, you may be in violation of Fish and Game Code section 1602. Also, even though you are entitled to complete the project without an agreement, you are still responsible for complying with all other applicable local, state, and federal laws, including, for example, the state and federal Endangered Species Acts and Fish and Game Code sections 5650 (water pollution) and 5901 (fish passage).

Finally, you must have a copy of this letter *and* your notification with all attachments available at all times at the work site. If you have any questions regarding this matter, please contact Dave Johnston, Environmental Scientist, at (831) 466-0234.

Sincerely,

Charles Armor
Acting Regional Manager
Bay Delta Region

cc: Lieutenant Nores

Addendum 1 - 6-19-09

FOR DEPARTMENT USE ONLY				
Project Name	Project Number	Project Date	State Department	Notification No.



STATE OF CALIFORNIA
DEPARTMENT OF FISH AND GAME
NOTIFICATION OF LAKE OR STREAMBED ALTERATION



Complete EACH field, unless otherwise indicated, following the enclosed instructions and submit ALL required enclosures. Attach additional pages, if necessary.

1. APPLICANT PROPOSING PROJECT

Name	David Sykes, Assistant Director, Department of Public Works			
Business/Agency	City of San Jose			
Street Address	200 E. Santa Clara Street, 5th Floor Tower			
City, State, Zip	San Jose, CA 95113			
Telephone	(408) 535-8300	Fax	(408) 292-6296	
Email	dave.sykes@sanjoseca.gov			

2. CONTACT PERSON (Complete only if different from applicant)

Name	Jan Palajac, Project Manager			
Street Address	200 E. Santa Clara Street, 6th Floor Tower			
City, State, Zip	San Jose, CA 95113			
Telephone	(408) 535-8350	Fax	(408) 292-6288	
Email	jan.palajac@sanjoseca.gov			

3. PROPERTY OWNER (Complete only if different from applicant)

Name	See Attached			
Street Address				
City, State, Zip				
Telephone		Fax		
Email				

4. PROJECT NAME AND AGREEMENT TERM

A. Project Name		Penitencia Creek Trail, Reach 6: Interim Improvements		
B. Agreement Term Requested		<input checked="" type="checkbox"/> Regular (5 years or less) <input type="checkbox"/> Long-term (greater than 5 years)		
C. Project Term		D. Seasonal Work Period		E. Number of Work Days
Beginning (year)	Ending (year)	Start Date (month/day)	End Date (month/day)	
2007	2009	01/01	12/31	120.00

Addendum 1-6-19-09

LAKE OR STREAMBED ALTERATION

5. AGREEMENT TYPE

Check the applicable box. If box B, C, D, or E is checked, complete the specified attachment.

A.	<input checked="" type="checkbox"/> Standard (Most construction projects, excluding the categories listed below)
B.	<input type="checkbox"/> Gravel/Sand/Rock Extraction (Attachment A) Mine I.D. Number: _____
C.	<input type="checkbox"/> Timber Harvesting (Attachment B) THP Number: _____
D.	<input type="checkbox"/> Water Diversion/Extraction/Impoundment (Attachment C) SWRCB Number: _____
E.	<input type="checkbox"/> Routine Maintenance (Attachment D)
F.	<input type="checkbox"/> DFG Fisheries Restoration Grant Program (FRGP) FRGP Contract Number: _____
G.	<input type="checkbox"/> Master
H.	<input type="checkbox"/> Master Timber Harvesting

6. FEES

Please see the current fee schedule to determine the appropriate notification fee. Itemize each project's estimated cost and corresponding fee. **Note: The Department may not process this notification until the correct fee has been received.**

	A. Project	B. Project Cost	C. Project Fee
1	Install trail on existing levee	\$175,000.00	\$1,100.00
2			
3			
4			
5			
		D. Base Fee (if applicable)	
		E. TOTAL FEE ENCLOSED	\$1,100.00

7. PRIOR NOTIFICATION OR ORDER

A. Has a notification previously been submitted to, or a Lake or Streambed Alteration Agreement previously been issued by, the Department for the project described in this notification?

☐ Yes (Provide the information below) ☒ No

Applicant: _____ Notification Number: _____ Date: _____

B. Is this notification being submitted in response to an order, notice, or other directive ("order") by a court or administrative agency (including the Department)?

☒ No ☐ Yes (Enclose a copy of the order, notice, or other directive. If the directive is not in writing, identify the person who directed the applicant to submit this notification and the agency he or she represents, and describe the circumstances relating to the order.)

☐ Continued on additional page(s)

Addendum 1 - 6-19-09

PROJECT LOCATION OF STREAMBED ALTERATION

8. PROJECT LOCATION

A. Address or description of project location. <i>(Include a map that marks the location of the project with a reference to the nearest city or town, and provide driving directions from a major road or highway)</i>					
The project is located along the south side of Penitencia Creek, between Mabury Road and King Road. Driving directions: from Hwy. 101, southbound: * take the Oakland Road exit, towards 13th Street * turn left on Oakland Road * turn right on Mabury Road * turn left on King Road * the project is accessible from King Road					
<input checked="" type="checkbox"/> Continued on additional page(s)					
B. River, stream, or lake affected by the project.		Penitencia Creek			
C. What water body is the river, stream, or lake tributary to?		Coyote Creek			
D. Is the river or stream segment affected by the project listed in the state or federal Wild and Scenic Rivers Acts?			<input type="checkbox"/> Yes <input checked="" type="checkbox"/> No <input type="checkbox"/> Unknown		
E. County		Santa Clara			
F. USGS 7.5 Minute Quad Map Name		G. Township	H. Range	I. Section	
Milpitas		Pueblo Lands			
<input type="checkbox"/> Continued on additional page(s)					
K. Meridian (check one)		<input type="checkbox"/> Humboldt <input checked="" type="checkbox"/> Mt. Diablo <input type="checkbox"/> San Bernardino			
L. Assessor's Parcel Number(s)					
254-19-13, 254-19-14, 254-19-39, 254-19-40, 254-19-42, 254-19-45, 254-19-46					
<input type="checkbox"/> Continued on additional page(s)					
M. Coordinates (If available, provide at least latitude/longitude or UTM coordinates and check appropriate boxes)					
Latitude/Longitude		Latitude: 37 22' 13" N		Longitude: 121 52' 17" W	
		<input checked="" type="checkbox"/> Degrees/Minutes/Seconds		<input type="checkbox"/> Decimal Degrees	
		<input type="checkbox"/> Decimal Degrees		<input type="checkbox"/> Decimal Minutes	
UTM		Easting:	Northing:	<input type="checkbox"/> Zone 10 <input type="checkbox"/> Zone 11	
Datum used for Latitude/Longitude or UTM		<input type="checkbox"/> NAD 27 <input checked="" type="checkbox"/> NAD 83 or WGS 84			

Addendum 1-6-19-09

LAKES OR STREAMBED ALTERATION

9. PROJECT CATEGORY AND WORK TYPE *(Check each box that applies)*

PROJECT CATEGORY	NEW CONSTRUCTION	REPLACE EXISTING STRUCTURE	REPAIR/MAINTAIN EXISTING STRUCTURE
Bank stabilization -bio engineering/recontouring	<input type="checkbox"/>	<input type="checkbox"/>	<input type="checkbox"/>
Bank stabilization -rip rap/retaining wall/gabion	<input type="checkbox"/>	<input type="checkbox"/>	<input type="checkbox"/>
Boat dock/pier	<input type="checkbox"/>	<input type="checkbox"/>	<input type="checkbox"/>
Boat ramp	<input type="checkbox"/>	<input type="checkbox"/>	<input type="checkbox"/>
Bridge	<input type="checkbox"/>	<input type="checkbox"/>	<input type="checkbox"/>
Channel clearing/vegetation management	<input type="checkbox"/>	<input type="checkbox"/>	<input type="checkbox"/>
Culvert	<input type="checkbox"/>	<input type="checkbox"/>	<input type="checkbox"/>
Debris basin	<input type="checkbox"/>	<input type="checkbox"/>	<input type="checkbox"/>
Dam	<input type="checkbox"/>	<input type="checkbox"/>	<input type="checkbox"/>
Diversion structure – weir or pump intake	<input type="checkbox"/>	<input type="checkbox"/>	<input type="checkbox"/>
Filling of wetland, river, stream, or lake	<input type="checkbox"/>	<input type="checkbox"/>	<input type="checkbox"/>
Geotechnical survey	<input type="checkbox"/>	<input type="checkbox"/>	<input type="checkbox"/>
Habitat enhancement –re vegetation/mitigation	<input type="checkbox"/>	<input type="checkbox"/>	<input type="checkbox"/>
Levee	<input type="checkbox"/>	<input type="checkbox"/>	<input type="checkbox"/>
Low water crossing	<input type="checkbox"/>	<input type="checkbox"/>	<input type="checkbox"/>
Road/trail	<input checked="" type="checkbox"/>	<input type="checkbox"/>	<input type="checkbox"/>
Sediment removal -pond , stream, or marina	<input type="checkbox"/>	<input type="checkbox"/>	<input type="checkbox"/>
Storm drain outfall structure	<input type="checkbox"/>	<input type="checkbox"/>	<input type="checkbox"/>
Temporary stream crossing	<input type="checkbox"/>	<input type="checkbox"/>	<input type="checkbox"/>
Utility crossing : horizontal Directional Drilling	<input type="checkbox"/>	<input type="checkbox"/>	<input type="checkbox"/>
Jack/bore	<input type="checkbox"/>	<input type="checkbox"/>	<input type="checkbox"/>
Open trench	<input type="checkbox"/>	<input type="checkbox"/>	<input type="checkbox"/>
Other (specify):	<input type="checkbox"/>	<input type="checkbox"/>	<input type="checkbox"/>

Addendum 1-36-19-c21

10. PROJECT DESCRIPTION

A. Describe the project in detail. Photographs of the project location and immediate surrounding area should be included.

- Include any structures (e.g., rip-rap, culverts, or channel clearing) that will be placed, built, or completed in or near the stream, river, or lake.
- Specify the type and volume of materials that will be used.
- If water will be diverted or drafted, specify the purpose or use.

Enclose diagrams, drawings, plans, and/or maps that provide all of the following: site specific construction details; the dimensions of each structure and/or extent of each activity in the bed, channel, bank or floodplain; an overview of the entire project area (i.e., "bird's-eye view") showing the location of each structure and/or activity, significant area features, and where the equipment/machinery will enter and exit the project area.

This project involves construction of an 8' wide, crushed gravel trail along the top of an existing levee, on the south side of Penitencia Creek. At the entry to the trail, at King Road, an asphalt trailhead will be constructed. The crushed gravel trail will lead away from the trailhead and run along the existing levee towards Mabury road. The trail will slope 2% away from the creek. Where the levee is too narrow to accommodate the width of the trail, the inland side will be expanded. A 10'x15' paved seating area with three benches will be constructed on the creek side of the trail. The trail will leave the existing levee to join an existing asphalt pathway. Where the trail joins the asphalt, the trail surface will change from crushed gravel to asphalt.

No work will be done in the active channel, nor will any work be done below the existing top of bank on the creek side of the levee.

Construction documents are attached.

☒ Continued on additional page(s)

B. Specify the equipment and machinery that will be used to complete the project.

Earthwork, paving and hydroseeding equipment will be used.

☐ Continued on additional page(s)

C. Will water be present during the proposed work period (specified in box 4.D) in the stream, river, or lake (specified in box 8.B).

☒ Yes ☐ No (Skip to box 11)

D. Will the proposed project require work in the wetted portion of the channel?

☐ Yes (Enclose a plan to divert water around work site)
☒ No

Addendum 1-6-19-09

FOOTPRINT OF LAKE OR STREAMBED ALTERATION

11. PROJECT IMPACTS

A. Describe impacts to the bed, channel, and bank of the river, stream, or lake, and the associated riparian habitat. Specify the dimensions of the modifications in length (linear feet) and area (square feet or acres) and the type and volume of material (cubic yards) that will be moved, displaced, or otherwise disturbed, if applicable.

The trail will run along the top of an existing levee below the existing tree canopy. No trees are slated for removal. No modification of grades around existing trees is anticipated. No materials will be moved, displaced, or otherwise disturbed.

☐ Continued on additional page(s)

B. Will the project affect any vegetation?

☒ Yes (Complete the tables below) ☐ No

Vegetation Type	Temporary Impact	Permanent Impact
Riparian canopy	Linear feet: 615 Total area: 5585	Linear feet: _____ Total area: _____
	Linear feet: _____ Total area: _____	Linear feet: _____ Total area: _____

Tree Species	Number of Trees to be Removed	Trunk Diameter (range)
N/A		

☐ Continued on additional page(s)

C. Are any special status animal or plant species, or habitat that could support such species, known to be present on or near the project site?

☒ Yes (List each species and/or describe the habitat below)

☐ No

☐ Unknown

Steelhead, California Red Legged Frog, Pallid Bat

☐ Continued on additional page(s)

D. Identify the source(s) of information that supports a "yes" or "no" answer above in Box 11.C.

Initial Study: Mabury Park/ Penitencia Creek Park Chain, Reach 6, Master Plan

☐ Continued on additional page(s)

E. Has a biological study been completed for the project site?

☒ Yes (Enclose the biological study)

☐ No

Note: A biological assessment or study may be required to evaluate potential project impacts on biological resources.

F. Has a hydrological study been completed for the project or project site?

☐ Yes (Enclose the hydrological study)

☒ No

Note: A hydrological study or other information on site hydraulics (e.g., flows, channel characteristics, and/or flood recurrence intervals) may be required to evaluate potential project impacts on hydrology.

12. MEASURES TO PROTECT FISH, WILDLIFE, AND PLANT RESOURCES

A. Describe the techniques that will be used to prevent sediment from entering watercourses during and after construction.

Fiber rolls will be installed along the top of bank, continuous. All work will be out of streambed. All work will be conducted under dry conditions, and no equipment will enter the creek channel.

☐ Continued on additional page(s)

B. Describe project avoidance and/or minimization measures to protect fish, wildlife, and plant resources.

N/A: No impact to fish, wildlife, and plant resources will occur, as all work will be performed on an existing levee, outside of the creek channel, and no trees are to be removed.

☐ Continued on additional page(s)

C. Describe any project mitigation and/or compensation measures to protect fish, wildlife, and plant resources.

N/A: Mitigation is not anticipated to be required because the project will not impact fish, wildlife, or plant resources.

☐ Continued on additional page(s)

13. PERMITS

List any local, state, and federal permits required for the project and check the corresponding box(es). Enclose a copy of each permit that has been issued.

A. Santa Clara Valley Water District Encroachment Permit ☒ Applied ☐ Issued

B. _____ ☐ Applied ☐ Issued

C. _____ ☐ Applied ☐ Issued

D. Unknown whether ☐ local, ☐ state, or ☐ federal permit is needed for the project. (Check each box that applies)

☐ Continued on additional page(s)

Addendum 1-6-19-09

LAKE OR STREAMBED ALTERATION

14. ENVIRONMENTAL REVIEW

<p>A. Is a draft or final document been prepared for the project pursuant to the California Environmental Quality Act (CEQA), National Environmental Protection Act (NEPA), California Endangered Species Act (CESA) and/or federal Endangered Species Act (ESA)?</p>			
<p><input checked="" type="checkbox"/> Yes (Check the box for each CEQA, NEPA, CESA, and ESA document that has been prepared and enclose a copy of each)</p> <p><input type="checkbox"/> No (Check the box for each CEQA, NEPA, CESA, and ESA document listed below that will be or is being prepared)</p>			
<p><input type="checkbox"/> Notice of Exemption</p> <p><input checked="" type="checkbox"/> Initial Study</p> <p><input type="checkbox"/> Negative Declaration</p> <p><input type="checkbox"/> TR/ NTMP</p>	<p><input checked="" type="checkbox"/> Mitigated Negative Declaration</p> <p><input type="checkbox"/> Environmental Impact Report</p> <p><input type="checkbox"/> Notice of Determination (Enclose)</p> <p><input type="checkbox"/> Mitigation, Monitoring, Reporting Plan</p>	<p><input type="checkbox"/> NEPA document (type): _____</p> <p><input type="checkbox"/> CESA document (type): _____</p> <p><input type="checkbox"/> ESA document (type): _____</p>	
<p>B. State Clearinghouse Number (if applicable)</p>		<p>2003052008</p>	
<p>C. Is a CEQA lead agency been determined?</p>		<p><input checked="" type="checkbox"/> Yes (Complete boxes D, E, and F) <input type="checkbox"/> No (Skip to box 14.G)</p>	
<p>D. CEQA Lead Agency</p>		<p>City of San Jose</p>	
<p>E. Contact Person</p>		<p>Jan Palajac</p>	<p>F. Telephone Number</p> <p>(408) 535-8350</p>
<p>G. If the project described in this notification is part of a larger project or plan, briefly describe that larger project or plan.</p> <p>N/A</p>			
<p><input type="checkbox"/> Continued on additional page(s)</p>			
<p>Has an environmental filing fee (Fish and Game Code section 711.4) been paid?</p>			
<p><input checked="" type="checkbox"/> Yes (Enclose proof of payment) <input type="checkbox"/> No (Briefly explain below the reason a filing fee has not been paid)</p>			
<p><i>Note: If a filing fee is required, the Department may not finalize a Lake or Streambed Alteration Agreement until the filing fee is paid.</i></p>			

15. SITE INSPECTION

<p>Check one box only.</p> <p><input checked="" type="checkbox"/> In the event the Department determines that a site inspection is necessary, I hereby authorize a Department representative to enter the property where the project described in this notification will take place at any reasonable time, and hereby certify that I am authorized to grant the Department such entry.</p> <p><input type="checkbox"/> I request the Department to first contact (insert name) _____ at (insert telephone number) _____ to schedule a date and time to enter the property where the project described in this notification will take place. I understand that this may delay the Department's determination as to whether a Lake or Streambed Alteration Agreement is required and/or the Department's issuance of a draft agreement pursuant to this notification.</p>
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Addendum 1-6-19-09

NOTIFICATION OF LAKE OR STREAMBED ALTERATION

16. DIGITAL FORMAT

Is any of the information included as part of the notification available in digital format (i.e., CD, DVD, etc.)?

☒ Yes (Please enclose the information via digital media with the completed notification form)

☐ No

17. SIGNATURE

I hereby certify that to the best of my knowledge the information in this notification is true and correct and that I am authorized to sign this notification as, or on behalf of, the applicant. I understand that if any information in this notification is found to be untrue or incorrect, the Department may suspend processing this notification or suspend or revoke any draft or final Lake or Streambed Alteration Agreement issued pursuant to this notification. I understand also that if any information in this notification is found to be untrue or incorrect and the project described in this notification has already begun, I and/or the applicant may be subject to civil or criminal prosecution. I understand that this notification applies only to the project(s) described herein and that I and/or the applicant may be subject to civil or criminal prosecution for undertaking any project not described herein unless the Department has been separately notified of that project in accordance with Fish and Game Code section 1602 or 1611.

D. D. Sykes

Signature of Applicant or Applicant's Authorized Representative



3/2/07

Date

DAVID SYKES

Print Name

Addendum 1-6-19-09

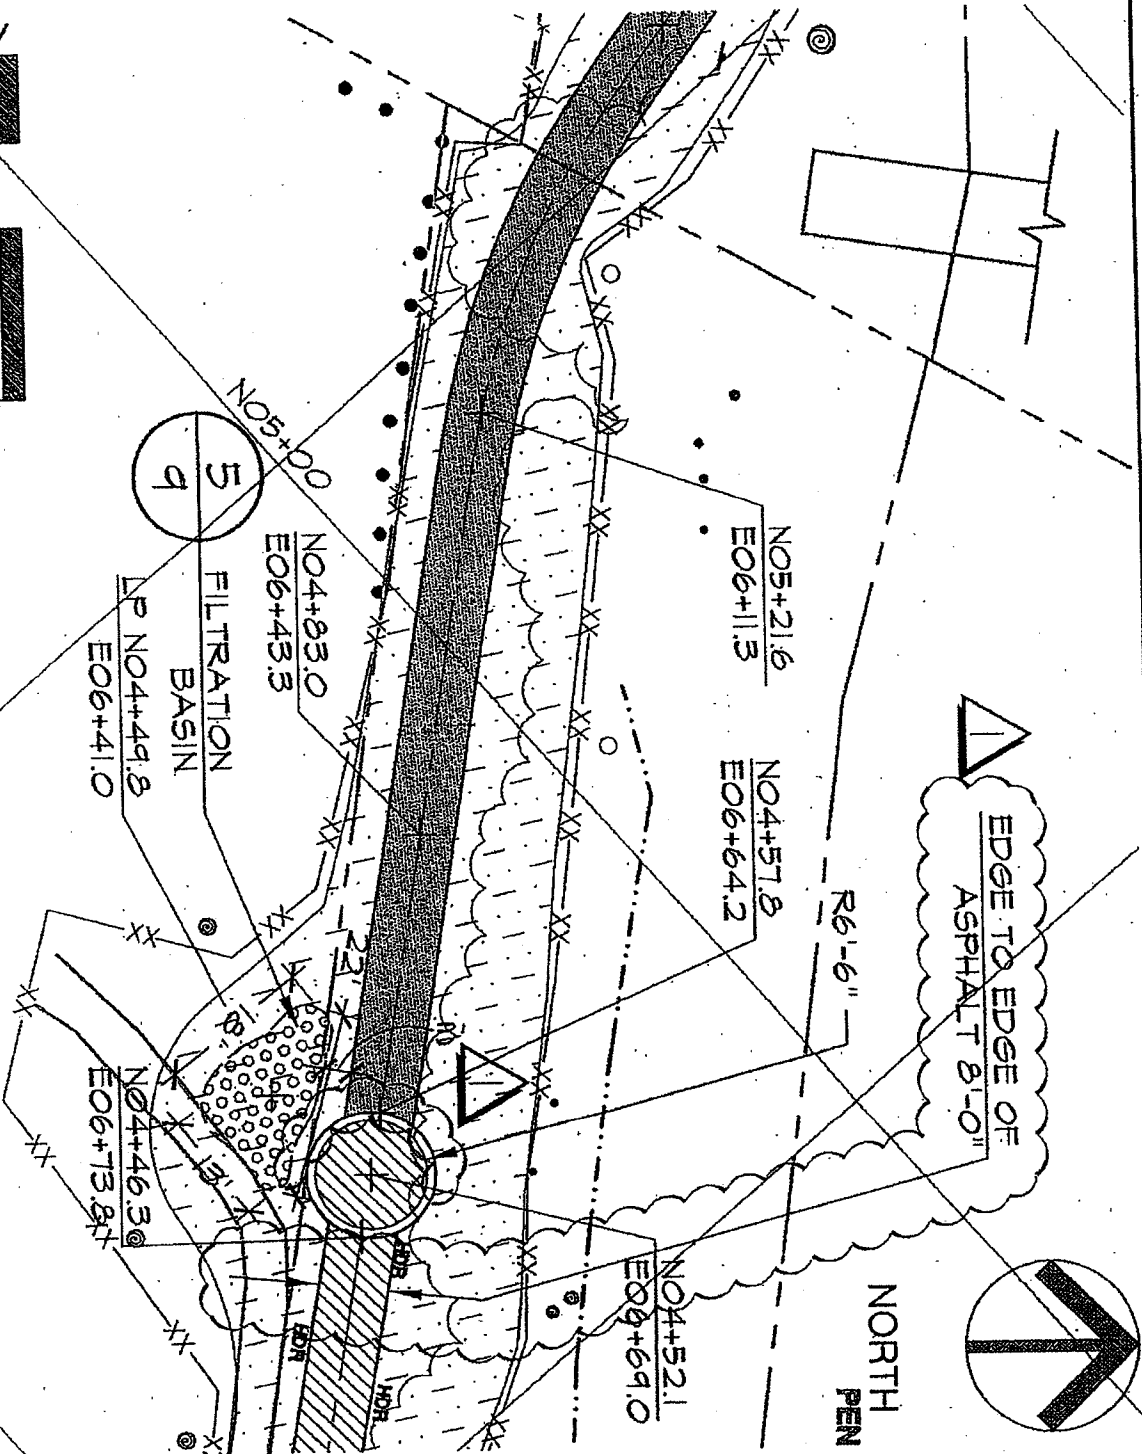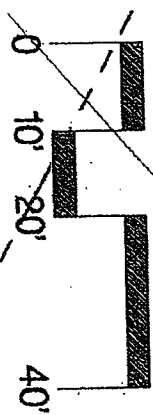

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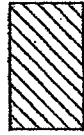
Callander Associates
Landscape Architecture
325 South First Street, Suite 300
San Jose, CA 95113
T 408.275.0565

ADDENDUM #1

SHEET 7 - SITE LAYOUT PLAN
PENITENCIA CREEK TRAIL REACH 6 INTERIM IMPROVEMENTS

DATE	SCALE	DRAWN BY	CHECKED BY:	DRAWING NO.
06/17/09	AS SHOWN	CS	MM	1 OF 5

SITE LAYOUT LEGEND



ASPHALT PAVEMENT $\frac{6}{9}$



COMPACTED BASE ROCK TRAIL $\frac{3}{9}$



EROSION CONTROL HYDROSEED, REFER TO SPECIFICATIONS



HDR
COMPACTED BASE ROCK SHOULDER $\frac{8}{9}$



EXISTING TREE, PROTECT IN PLACE

N04+44.8
E10+78.3
COORDINATE POINTS AT NORTHING 04+44.8
AND EASTING 78.3

R/20'-6" RADIUS



LOW POINT



FLUSH

TOP OF BANK - CREEK SIDE OF LEVEE

TOP OF LEVEE - INLAND SIDE OF LEVEE

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325 South First Street, Suite 300
San Jose, CA 95113
T 408.275.0565

ADDENDUM #1

SHEET 8 - SITE LAYOUT PLAN

PENITENCIA CREEK TRAIL REACH 6 INTERIM IMPROVEMENTS

DATE 06/17/09	SCALE AS SHOWN	DRAWN BY CS	CHECKED BY: MM	DRAWING NO. 2 OF 5
------------------	-------------------	----------------	-------------------	-----------------------


Addendum 1 - 6_19_09

3

COMPACTED BASE ROCK TRAIL

9 SECTION

GRAVEL-TRAIL.DWG

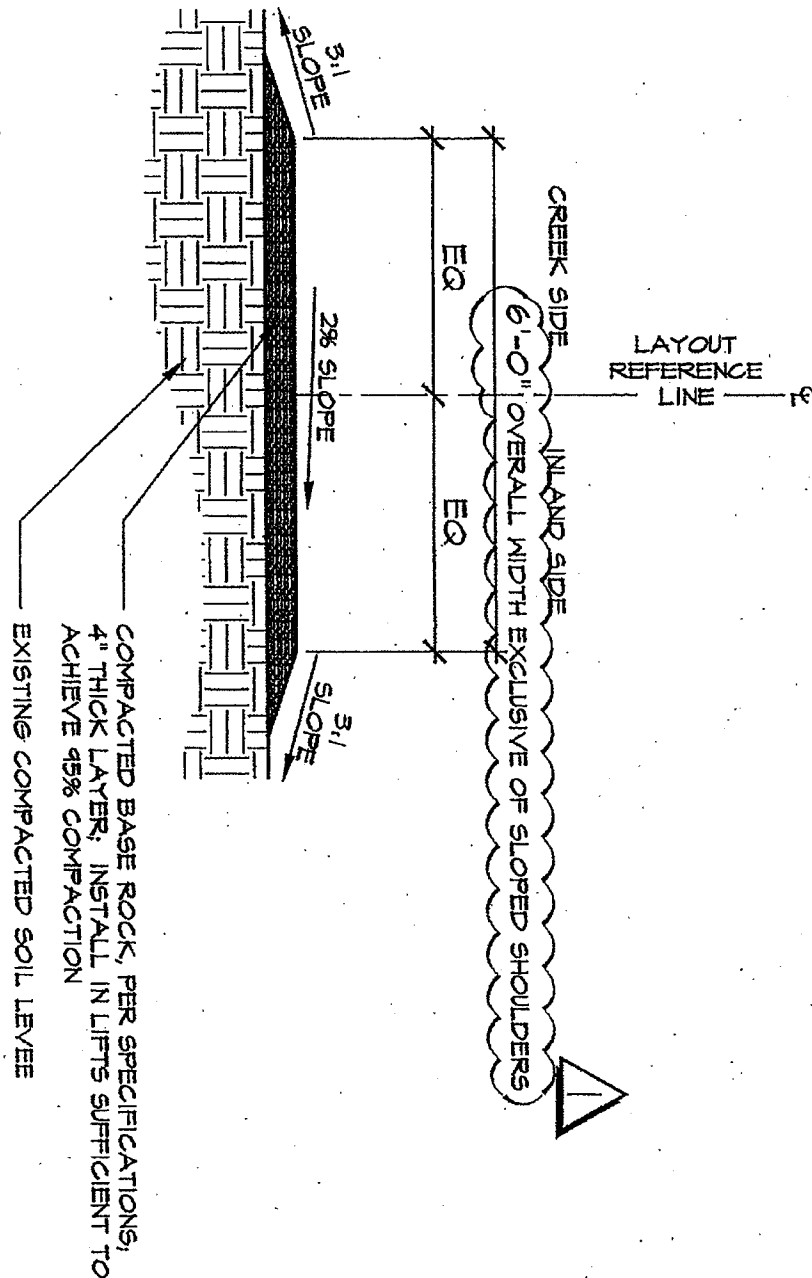

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Callander Associates
Landscape Architecture
325 South First Street, Suite 300
San Jose, CA 95113
T 408.275.0565

ADDENDUM #1

SHEET 9 - DETAILS

PENITENCIA CREEK TRAIL REACH 6 INTERIM IMPROVEMENTS

DATE	SCALE	DRAWN BY	CHECKED BY:	DRAWING NO.
06/17/09	AS SHOWN	CS	MM	3 OF 5


Addendum 1 - 6_19_09

6

ASPHALT CONCRETE PAVEMENT

9

SECTION

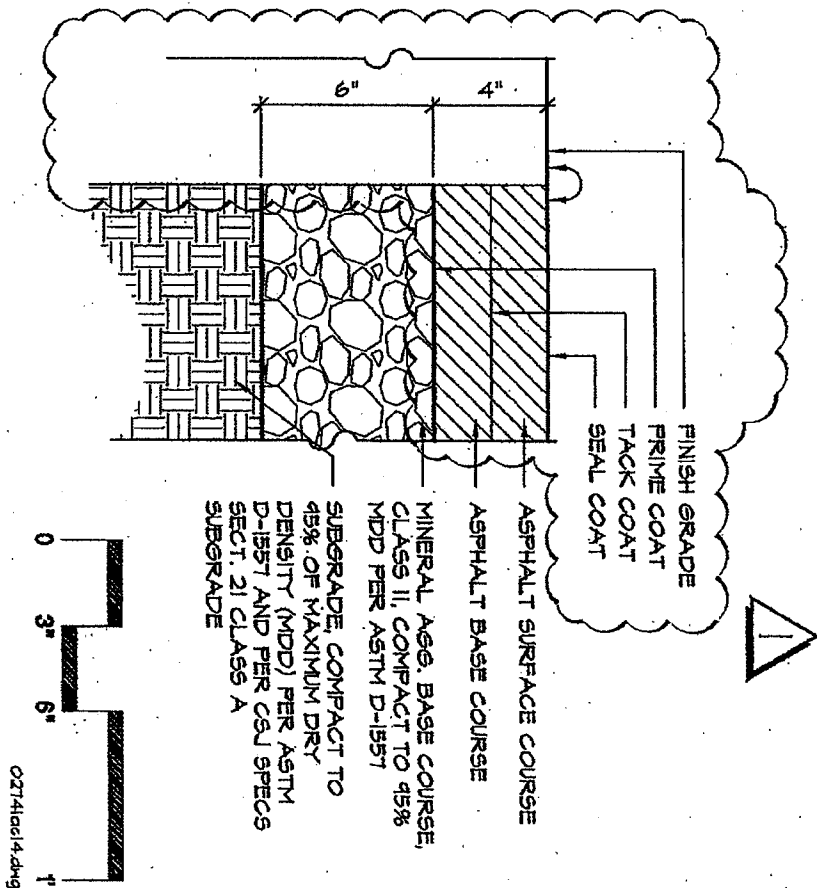

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Callander Associates
Landscape Architecture
325 South First Street, Suite 300
San Jose, CA 95113
T 408.275.0565

ADDENDUM #1

SHEET 9 - DETAILS

PENITENCIA CREEK TRAIL REACH 6 INTERIM IMPROVEMENTS

DATE
06/17/09

SCALE
AS SHOWN

DRAWN BY
CS

CHECKED BY:
MM


DRAWING NO.
4 OF 5

Addendum 1 - 6_19_09

8
9

COMPACTED BASEROCK SHOULDER


VARIES

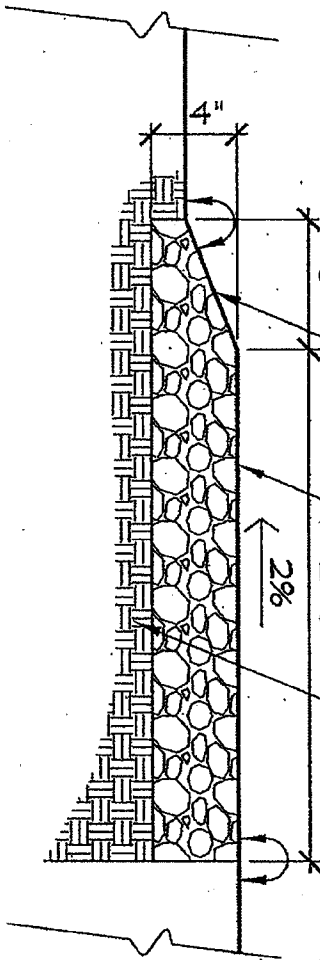

SLOPE TO CONFORM TO GRADE

SHOULDER, COMPACTED BASE ROCK PER SPECIFICATIONS; INSTALL IN LIFTS SUFFICIENT TO ACHIEVE 95% COMPACTION

SUBGRADE, COMPACT TO 95%

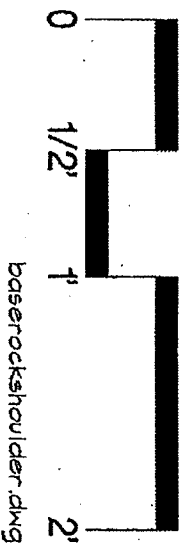

baserockshoulder.dwg

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ADDENDUM #1

SHEET 9 - DETAILS

PENITENCIA CREEK TRAIL REACH 6 INTERIM IMPROVEMENTS

DATE	SCALE	DRAWN BY	CHECKED BY:	DRAWING NO.
06/17/09	AS SHOWN	CS	MM	5 OF 5

Addendum 1 - 6_19_09



Coastal Conservancy Representation on Signs

The Coastal Conservancy requests that it be represented by its logo on signs installed at project sites.

The Conservancy's complete logo is shown below:



Digital and photo-ready copies of the logo, and guidelines for its use, are available from the Conservancy's Communications Director, Dick Wayman, at (510) 286-4182, or dwayman@scc.ca.gov.

Any use of the Conservancy's name and logo on signs must be approved in advance by the Conservancy.

The Conservancy requests the opportunity to participate in the drafting of text and design for signs that will display the Conservancy's logo, or that are prepared, in whole or in part, with Conservancy funds.

9/19/01

1330 Broadway, 13th Floor
Oakland, California 94612-2512
510-286-1015 Fax: 510-286-0470

C a l i f o r n i a S t a t e C o a s t a l C o n s e r v a n c y

Addendum 1 - 6_19_09

Graphic Guidelines For Trademark

BASIC DESIGN GUIDELINES

Trademark Description

The trademark of the Coastal Conservancy, shown on the upper left of this page, consists of a symbol and logotype, and they are always used together.

The Coastal Conservancy symbol is derived from the pattern of the California horn shell and water. The logotype for the Coastal Conservancy trademark utilizes the font Bembo Roman.

Incorrect Trademark Usage

1. Do not modify the symbol.
2. Do not alter the size relationship of the symbol and the logotype.
3. Do not align the symbol to the left or the right of the logotype.
4. Do not use the trademark at a size smaller than one inch wide.

Trademark Color Usage

The preferred color usage of the Coastal Conservancy trademark is PMS 315 Blue. The trademark may also be used in black and white.

USE OF THE TRADEMARK ON SIGNS

The Coastal Conservancy requests that it be represented by its trademark on signs installed at project sites.

Digital and photo-ready copies of the trademark are available from the Conservancy's Communications Director, Dick Wayman, at (510) 286-4182.

Any use of the Conservancy's name and trademark on signs must be approved in advance by the Conservancy.

The Conservancy requests the opportunity to participate in the drafting of text and design for signs that will display the Conservancy's trademark, or that are prepared for projects funded, in whole or in part, by the Conservancy.

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